


DIMENSION TABLE								
PIPE DIAM.	TEST PRESSURE (PSI)	BEND ANGLE	CONCRETE VOLUME (FT ³)	CUBE SIZE (FT)	TIE ROD DIAM.	TIE ROD EMBENMENT		
4"	250	11.25^	6	1.8		17"		
		22.5^	12	2.3	5/8"			
		45^	22	2.8				
6"	250	11.25^	14	2.4	5/8"	17"		
		22.5^	27	3.0				
		45^	50	3.7				
8"	250	11.25^	25	2.9	5/8"	17"		
		22.5^	48	3.6				
		45^	89	4.5				
10"	250	11.25^	38	3.4	5/8"	17"		
		22.5^	75	4.2				
		45^	139	5.2				
12"	250	11.25^	55	3.8	F /O"	17"		
		22.5^	108	4.8	5/8"			
		45^	200	5.8	7/8"	24"		
14"	250	11.25^	75	4.2	5/8"	17"		
		22.5^	147	5.3	3/4"	20"		
		45^	272	6.5	1"	27"		
16"	250	11.25^	98	4.6	5/8"	17"		
		22.5^	192	5.8	7/8"	24"		
		45^	355	7.1	1 1/8"	30"		

CONCRETE THRUST BLOCK DETAIL CS103 SCALE: N.T.S.

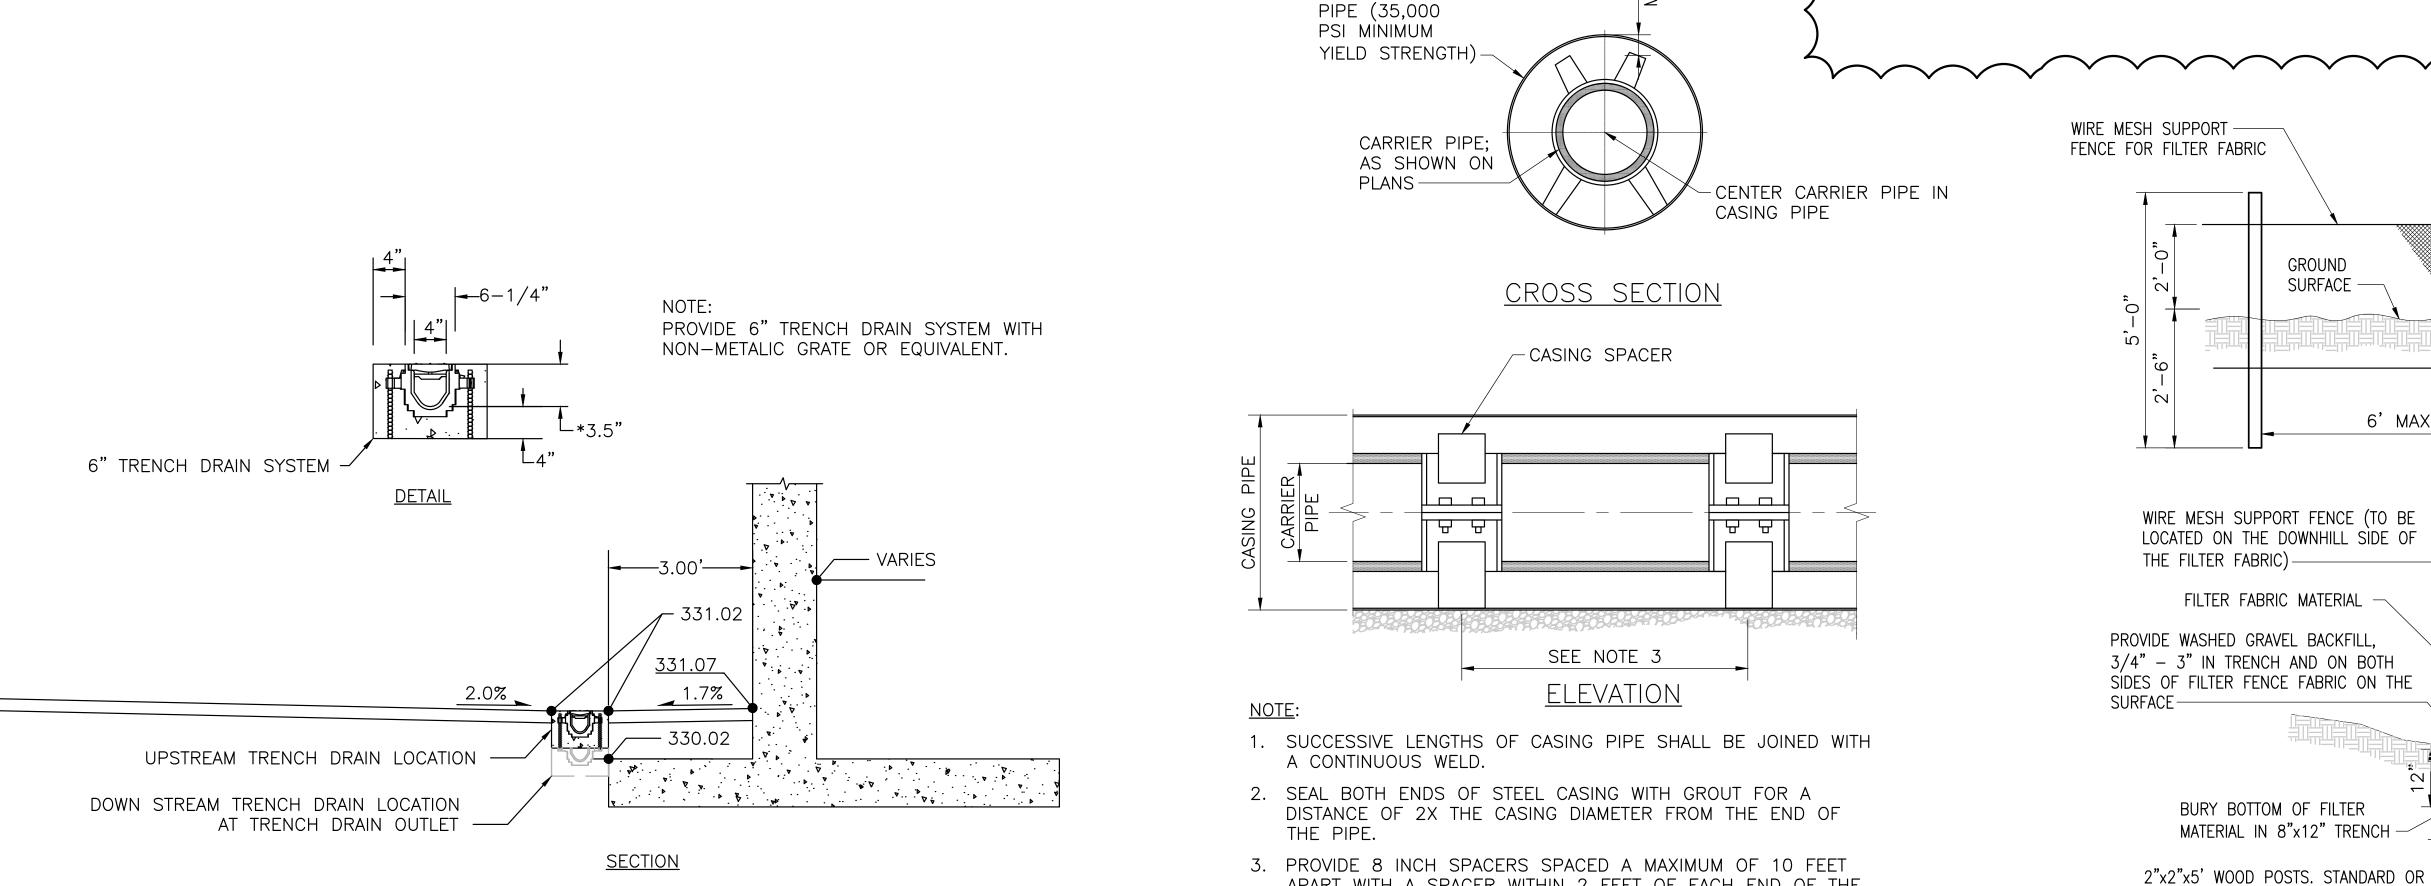

- FILTER FABRIC MATERIAL IN WIRE MESH SUPPORT -CONTINUOUS ROLLS USE FENCE FOR FILTER FABRIC STAPLES OR WIRE RINGS TO ATTACH FABRIC TO WIRE $^-$ 2"x2" WOOD POSTS. SURFACE -STANDARD, BETTER OR EQUIVALENT -BURY BOTTOM OF 6' MAX FILTER MATERIAL IN 8"x12" TRENCH

WIRE MESH SUPPORT FENCE (TO BE LOCATED ON THE DOWNHILL SIDE OF THE FILTER FABRIC) -FILTER FABRIC MATERIAL PROVIDE WASHED GRAVEL BACKFILL, 3/4" - 3" IN TRENCH AND ON BOTH SIDES OF FILTER FENCE FABRIC ON THE SURFACE-BURY BOTTOM OF FILTER MATERIAL IN 8"x12" TRENCH -

BETTER OR EQUIVALENT -

6

- 1. FILTER FABRIC SHALL BE PURCHASED IN A CONTINUOUS ROLL AND CUT TO THE LENGTH OF THE BARRIER TO AVOID USE OF JOINTS. WHEN JOINTS ARE NECESSARY FILTER CLOTH SHALL BE SPLICED TOGETHER ONLY AT THE SUPPORT POST, WITH A MINIMUM 6-INCH OVERLAP, AND SECURELY FASTENED AT BOTH ENDS TO POST.
- 2. SILT FENCE SHOWN ON THE EROSION CONTROL SHEETS ARE FOR REFERENCE ONLY, EXACT LOCATIONS SHALL BE DETERMINED IN THE FIELD DURING CONSTRUCTION.
- 3. POST SHALL BE SPACED A MAXIMUM OF 6 FEET APART AND DRIVEN SECURELY INTO THE GROUND (MINIMUM OF 30 INCHES).
- 4. A TRENCH SHALL BE EXCAVATED APPROXIMATELY 8 INCHES WIDE AND 12 INCHES DEEP ALONG THE LINE OF POST AND UPSLOPE FROM THE BARRIER. THIS TRENCH SHALL BE BACKFILLED WITH WASHED GRAVEL.
- WHEN STANDARD STRENGTH FILTER FABRIC IS USED, A WIRE MESH SUPPORT FENCE SHALL BE FASTENED SECURELY TO THE UPSLOPE SIDE OF THE POST USING A HEAVY-DUTY WIRE STAPLES AT LEAST 1 INCH LONG, TIE WIRES OR HOG RINGS.THE WIRE SHALL EXTEND INTO THE TRENCH A MINIMUM OF 4 INCHES AND SHALL NOT EXTEND MORE THAN 24 INCHES ABOVE THE ORIGINAL GROUND SURFACE.
- 5. THE STANDARD STRENGTH FILTER FABRIC SHALL BE STAPLED OR WIRED TO THE FENCE, AND 20 INCHES OF THE FABRIC SHALL BE EXTENDED TO THE TRENCH. THE FABRIC SHALL NOT EXTEND MORE THAN 24 INCHES ABOVE THE ORIGINAL GROUND SURFACE. FILTER FABRIC SHALL NOT BE STAPLED TO EXISTING TREES.
- 7. WHEN EXTRA-STRENGTH FILTER FABRIC AND CLOSER POST SPACING IS USED, THE WIRE MESH SUPPORT FENCE MAY BE ELIMINATED. IN SUCH CASE, THE FILTER FABRIC IS STAPLED OR WIRED DIRECTLY TO THE POST WITH ALL OTHER PROVISIONS
- 8. FILTER FABRIC FENCES SHALL NOT BE REMOVED BEFORE THE UPSLOPE AREA HAS BEEN PERMANENTLY STABILIZED.
- 9. FILTER FABRIC FENCES SHALL BE INSPECTED IMMEDIATELY AFTER EACH RAINFALL AND AT LEAST DAILY DURING PROLONGED RAINFALL. ANY REQUIRED REPAIRS SHALL BE MADE IMMEDIATELY.
- 10. SILT FENCES WILL BE INSTALLED PARALLEL TO ANY SLOPE CONTOURS.
- 11. CONTRIBUTING LENGTH TO FENCE WILL NOT BE GREATER THAN 100 FEET.
- 12. DO NOT INSTALL BELOW AN OUTLET PIPE OR WEIR.
- 13. INSTALL <u>DOWNSLOPE</u> OF EXPOSED AREAS.

OF ABOVE NOTES APPLYING.


14. DO NOT DRIVE OVER OR FILL OVER SILT FENCES.

3 FILTER FABRIC FENCE CS102 SCALE: N.T.S. AMENDMENT DRAWING

SUPERSEDES CS 107

	_		II TANTO	
	_	CONSULTANTS:		
	_			
	_		BergerABAM	
	-			
	_			
	_		33301 9th Avenue South, Suite 300	
	_		Federal Way, Washington 98003-2600	
VISION 1	04-01-2016		(206) 431-2300 Fax: (206) 431-2250	
sions:	Date			

A SECTION A-A CS103 SCALE: N.T.S.

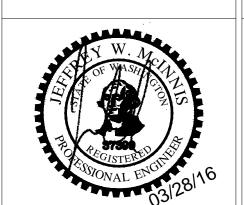

3 4

CASING PIPE.

STEEL CASING

ARCHITECT/ENGINEERS: SÄZÄN GROUP 600 Stewart St., Ste 1400 Seattle, Washington 98101 Tel 206.267.1700 Fax 206.267.1701


APART WITH A SPACER WITHIN 2 FEET OF EACH END OF THE

2 CASING PIPE - SCALE: N.T.S.

Drawing Title DETAIL SHEET Approved: Project Director VAPAHCS PLANNING AND ENGINEERING

Project Title Project Number 663-15-102 VA PUGET SOUND HEALTH CARE SYSTEM UPGRADE SEATTLE ELECTRICAL **Building Number** DISTRIBUTION FROM 5kV TO 15kV Drawing Number 1660 South Columbian Way, Seattle, WA 98108 **CS107R** Checked STORY BUDSBERG Dwg. 7 of 10

Office of Construction and Facilities Management Department of Veterans Affairs

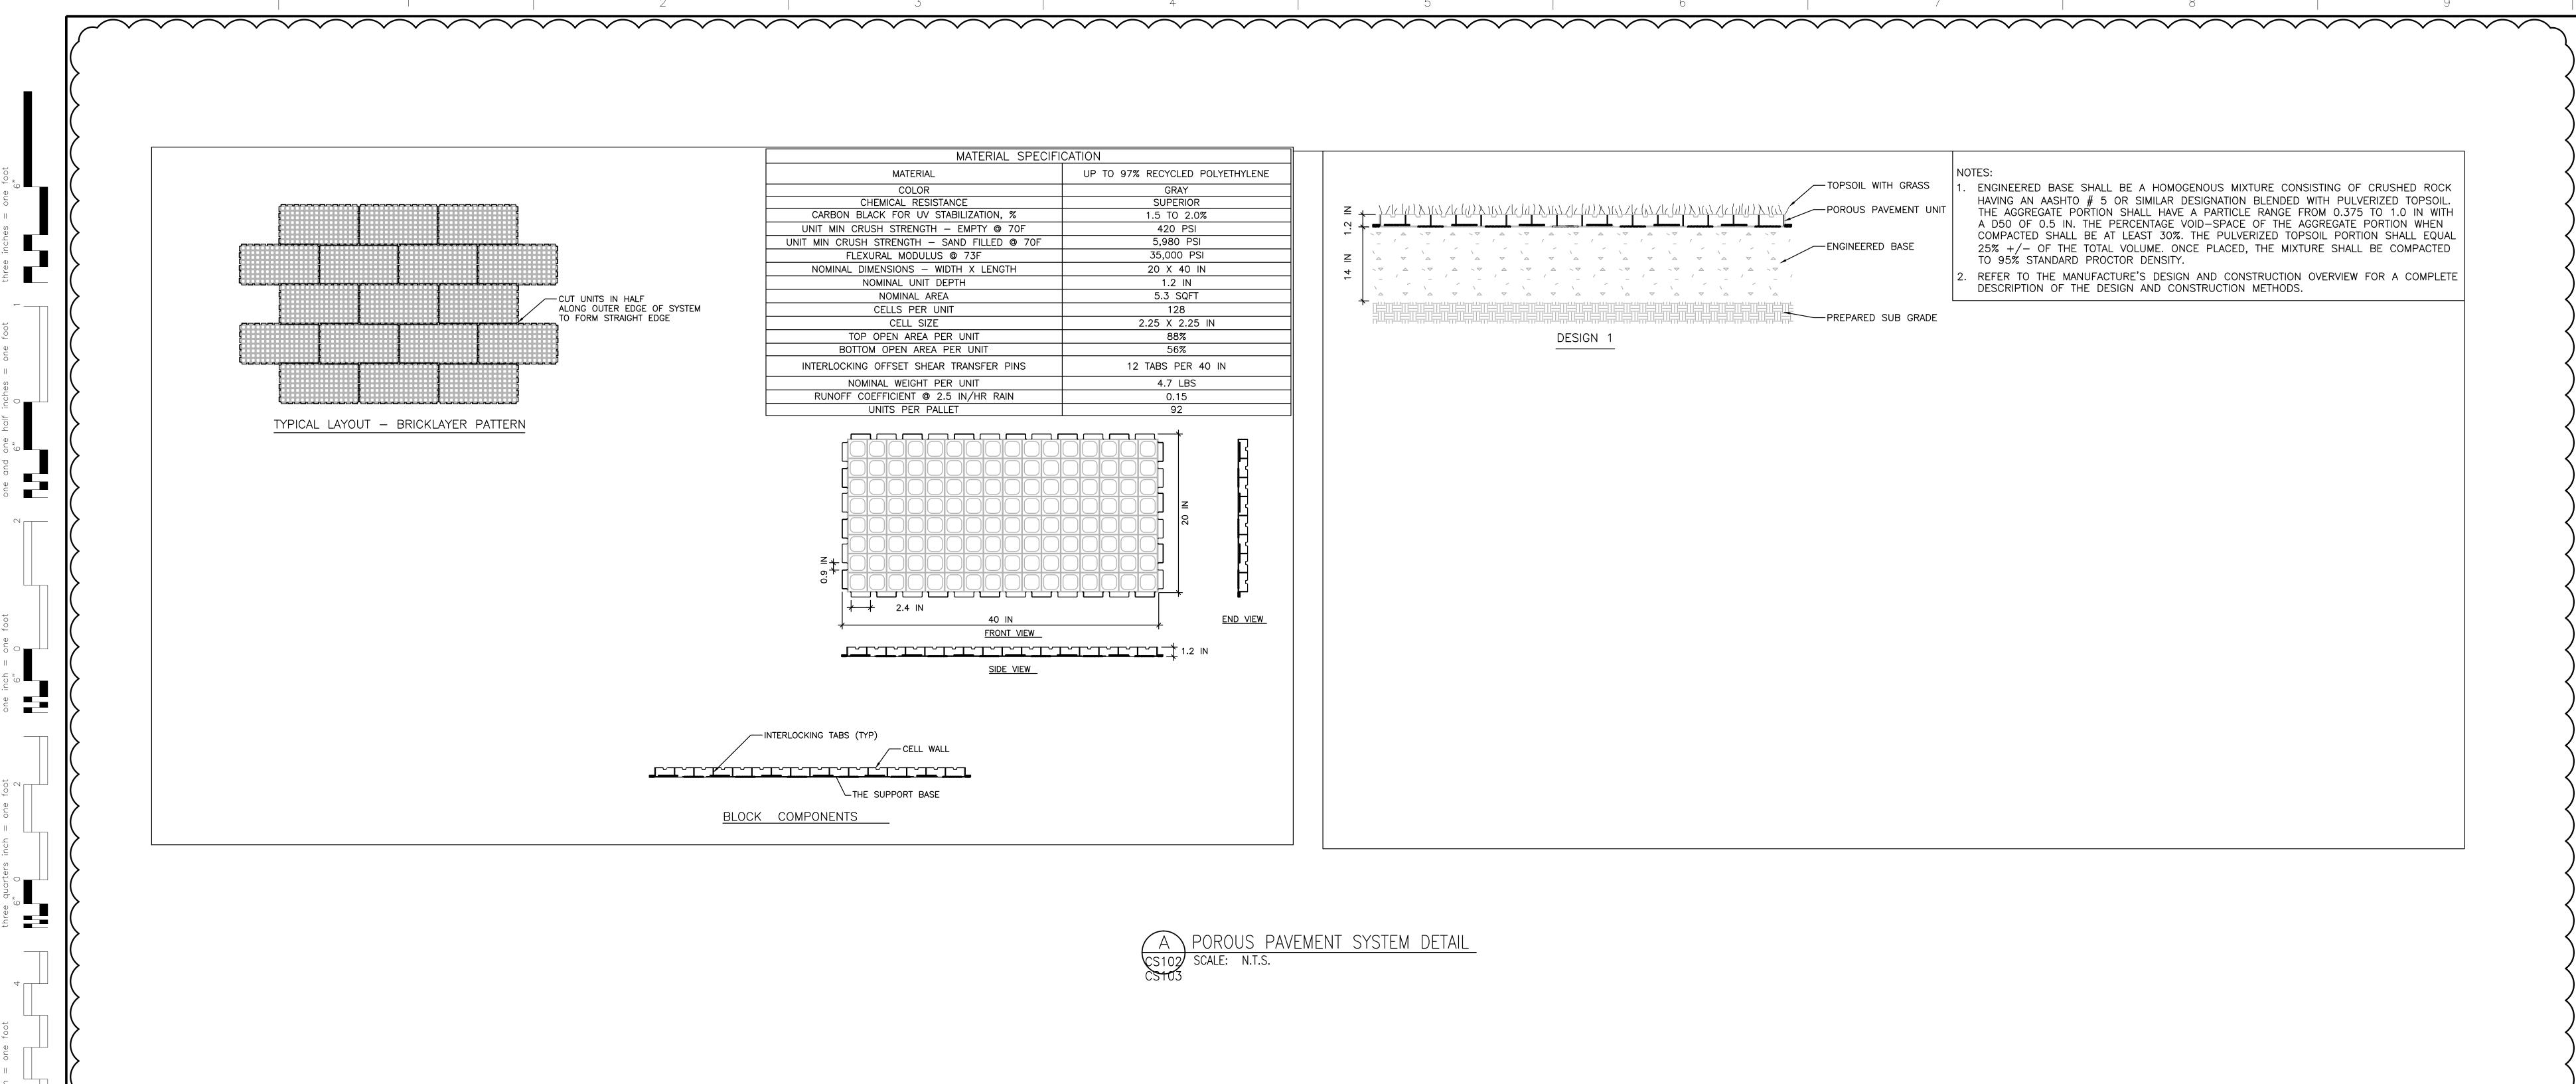

AMENDMENT DRAWING

Drawing Title Project Title Project Number 663-15-102 VA PUGET SOUND HEALTH CARE SYSTEM DETAIL SHEET UPGRADE SEATTLE ELECTRICAL **Building Number** 100 DISTRIBUTION FROM 5kV TO 15kV Approved: Project Director Drawing Number 1660 South Columbian Way, Seattle, WA 98108 **CS108R** Checked VAPAHCS PLANNING AND ENGINEERING

and Facilities Management Department of Veterans Affairs

NEW DRAWING

Office of

Construction

33301 9th Avenue South, Suite 300 Federal Way, Washington 98003-2600 (206) 431-2300 Fax: (206) 431-2250 REVISION 1 04-01-2016 Date

VA FORM 08-6231

CONSULTANTS:

BergerABAM

ARCHITECT/ENGINEERS: SÄZÄN GROUP 600 Stewart St., Ste 1400 Seattle, Washington 98101

Tel 206.267.1700 Fax 206.267.1701

04-01-2016

STORY BUDSBERG

Dwg. 8 of 10

